

CODEFOOTPRINT

1	GRAPHIC BAR SCALE	PROVIDED
2	NORTH DIRECTIONAL ARROW	PROVIDED
3	COMPLETE BUILDING FLOOR PLAN WITH A CLEAR	PROVIDED
	IDENTIFICATION OF NEW, REMODELED AND EXISTING PORTIONS	
4	IDENTIFICATION OF ALL PERMANENT PARTITIONS TALLER	PROVIDED
	THAN 6'	
5	A LABEL WITH PLAIN TEXT, KEYNOTES OR LEGENDS FOR EACH	PROVIDED
	ROOM AND SPACE	
6	OCCUPANT LOAD OF ASSEBLY ROOMS AND TOTAL OCCUPANT	PROVIDED
	FOR EACH FLOOR LEVEL	
7	IDENTIFICATION OF OPENINGS AND RATINGS OF STAIR	PROVIDED
	AND SHAFT ENCLOSURES	
8	IDENTIFICATION OF OPENINGS AND RATINGS OF CORRIDORS AND	PROVIDED
	OPENINGS	
9	IDENTIFICATION OF OCCUPANCY AND AREA SEPERATION	PROVIDED
10	IDENTIFICATION OF ALL HORIZONTAL EXIT ARRANGEMENTS, EXIT	PROVIDED
	PASSAGEWAYS, AND SMOKE COMPARTMENTS	
11	IDENTIFICATION OF ALL REQUIRED EXTERIOR EXITS AND EXIT	PROVIDED
	CAPACITY	
12	THE LOCATION OF THE CENTRAL FIRE ALARM CONTROL PANEL	EXISTING
	ANY REMOTE ANNUNCIATOR PANELS	
13	LOCATION OF EACH FIRE DEPARTMENT SUPPLY CONNECTION	EXISTING
14	LOCATION OF FIRE DEPARTMENT ACCESS ROADS AND FIRE	EXISTING
	HYDRANTS	
15	DISTANCE TO PROPERTY LINES AND EXPOSURES	EXISTING
16	IDENTIFICATION OF ANY SPECIAL HAZARDS OR CONDITIONS	N/A
17	LOCATION OF ANY ANTICIPATED FUTURE ADDITIONS	N/A

M OCCUPANCY 72 OCCUPANTS PER 1997 UPC - TABLE 4-1: RESTAURANTS, PUBS AND LOUNGES SUBTOTALS PER 1997 UPC - 413.6 - OCCUPANT LOAD IS LESS THAN 100 COMBINED EMPLOYEE AND

PER 1997 UPC TABLE 4-1: MEN - WC: 1 PER 50 36/50 = .72 WC REQ'D PER 1997 UPC TABLE 4-1: WOMEN - WC: 1 PER 50 36/50 = .72 WC REQ'D

TOTALS MEN - 1 WC PROVIDED

MEN - 1 LAV PROVIDED WOMEN - 1 WC PROVIDED WOMEN - 1 LAV PROVIDED 1 SERVICE SINK - PROVIDED - EXISTING


PLUMBING FIXTURE COUNT

PER 1997 UPC - TABLE 4-1 - DRINKING FOUNTAINS ARE NOT REQUIRED

GENERAL CONTRACTOR NOTES:


- 1. CONTRACTOR IS RESPONSIBLE TO CALL FOR INSPECTIONS, OBTAIN PERMITS AND FINAL CERTIFICATE OF OCCUPANCY.
- 2. CONTRACTOR TO COORDINATE WITH OWNER FOR WORKING ON SITE
- RULES AND REGULATIONS. PRIOR TO CONSTRUCTION CONTRACTOR SHALL PROVIDE INSURANCE
- CERTIFICATES ACCEPTABLE TO OWNER. PRIOR TO SUBMITTING BID, CONTRACTOR SHALL BECOME FAMILAR WITH THE EXISTING SPACE, ARCHITECTURAL PLANS AND IF THERE IS A
- DISCREPANCY AND SHALL NOTIFY THE ARCHITECT IMMEDIATELY. 5. CONTRACTOR TO COORDINATE WITH OWNER FOR CONNECTION TO BUILDING HVAC SYSTEM, ELECTRICAL SERVICE, TELEPHONE AND DATA SERVICE.
- 6. DAMAGES: PROMPTLY REPAIR DAMAGES TO EXISTING CONSTRUCTION
- TO REMAIN CAUSED BY DEMOLITION WORK. 7. CLEAN OUT: CONTRACTOR SHALL REMOVE ALL OBJECTS FROM SITE
- AFTER NEW CONSTRUCTION IS COMPLETED. 8. PROTECTION: CONTRACTOR SHALL PROVIDE FOR PROPER BARRICADES, LIGHTING SIGNAGE TO PROTECT THE EXISTING BUILDING, PARKING LOT, PUBLIC AND WORKERS. CONTRACTOR TO PROVIDE "SAFE"
- ACCESS TO SPACES AT ALL TIMES. 9. CONTRACTOR AT CLOSE OUT IS TO MAKE SURE ALL WARRANTIES ARE SUBMITTED TO BUILDING OWNER.
- 10. CONTRACTOR TO NOT INTERFERE WITH ADJACENT TENANTS, NO DEBRIS TO INTERFERE WITH THE PUBLIC - CHECK WITH BUILDING OWNER FOR LOCATION FOR TRASH DUMPSTER.

ILLUMINATED EXIT LIGHTS	PROVIDED	
FIRE EXTINGUISHERS	PROVIDED	
FIRE SUPPRESSION SYSTEM	N/A	
FIRE SUFFRESSION STSTEM	IN/A	
ACCESSIBILITY PROVISIONS		
EXISTING ADA COMPLIANT PARKING	N/A	
NEW ADA COMPLIANT RESTROOMS	N/A	
BUILDING CODE STANDARDS		
PER 2006 INTERNATIONAL BUILDING CODE		
OCCUPANCY TYPE	A-2	
CONSTRUCTION TYPE	III-B	
	ALLOWABLE	ACTUAL
BASIC ALLOWABLE FLOOR AREA PER FLOOR (SF)	9,500	1,769
ALLOWABLE STORIES	2	1
FRONTAGE INCREASE (%)	N/A	N/A
SPRINKLER INCREASE (%)	N/A	N/A
TOTAL ALLOWABLE FLOOR AREA (SF)	9,500	1,769
ALLOWABLE BULIDNG HEIGHT	45 FEET	
ACTUAL BUILDING HEIGHT FROM ADJACENT GRADE	EXISTING	
SUBTOTAL ACTUAL FLOOR AREA	EXISTING	
TOTAL ACTUAL FLOOR AREA	EXISTING	
BUILDING RESISITIVE CONSTRUCTION REQUIREMENTS		
PER 2006 INTERNATIONAL BUILDING CODE TABLE 601		
STRUCTURAL FRAME	0	
EXTERIOR BEARING WALLS	2	
INTERIOR BEARING WALLS	0	
INTERIOR NON-BEARING WALLS	0	
FLOOR CONSTRUCITON	0	
ROOF CONSTRUCTION	0	
STAIR/MECHANCIAL SHAFTS	0	
PER 2006 INTERNATIONAL BUILDING CODE TABLE 705.4		
PARTY WALL FIRE RESISTANCE RATING	3	

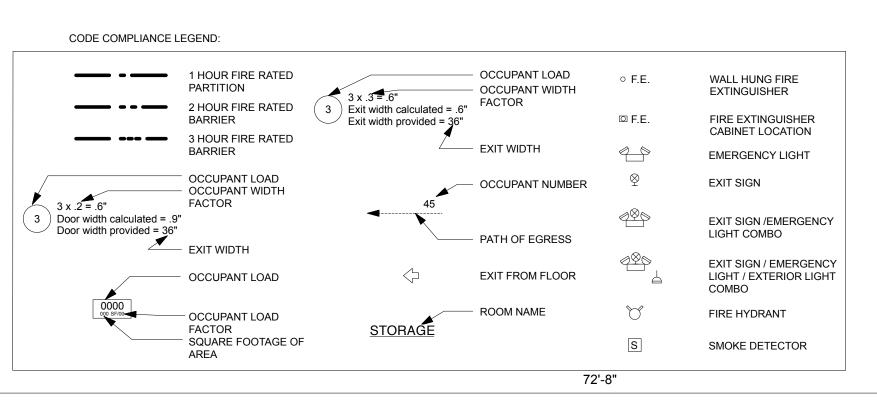

DRAWING INDEX

- A1 CODE COMPLIANCE FLOOR PLAN, INDEX TO DRAWINGS
- A2 FLOOR PLAN A3 REFLECTED CEILING PLAN & FINISH PLAN
- A4 WALL SECTIONS
- A5 WALL SECTIONS
- A6 INTERIOR ELEVATIONS, FINISH SCHEDULE A7 DOOR SCHEDULES, SPECS
- A8 SPECS A9 INTERIOR ELEVATIONS, EXTERIOR ELEVATIONS AND WINDOWS
- A10 KITCHEN EQUIPMENT SCHEDULE
- M100 MECHANICAL PLANS E100 ELECTRICAL PLANS
- P100 PLUMBING PLANS - WATER
- P200 PLUMBING PLANS DRAINAGE

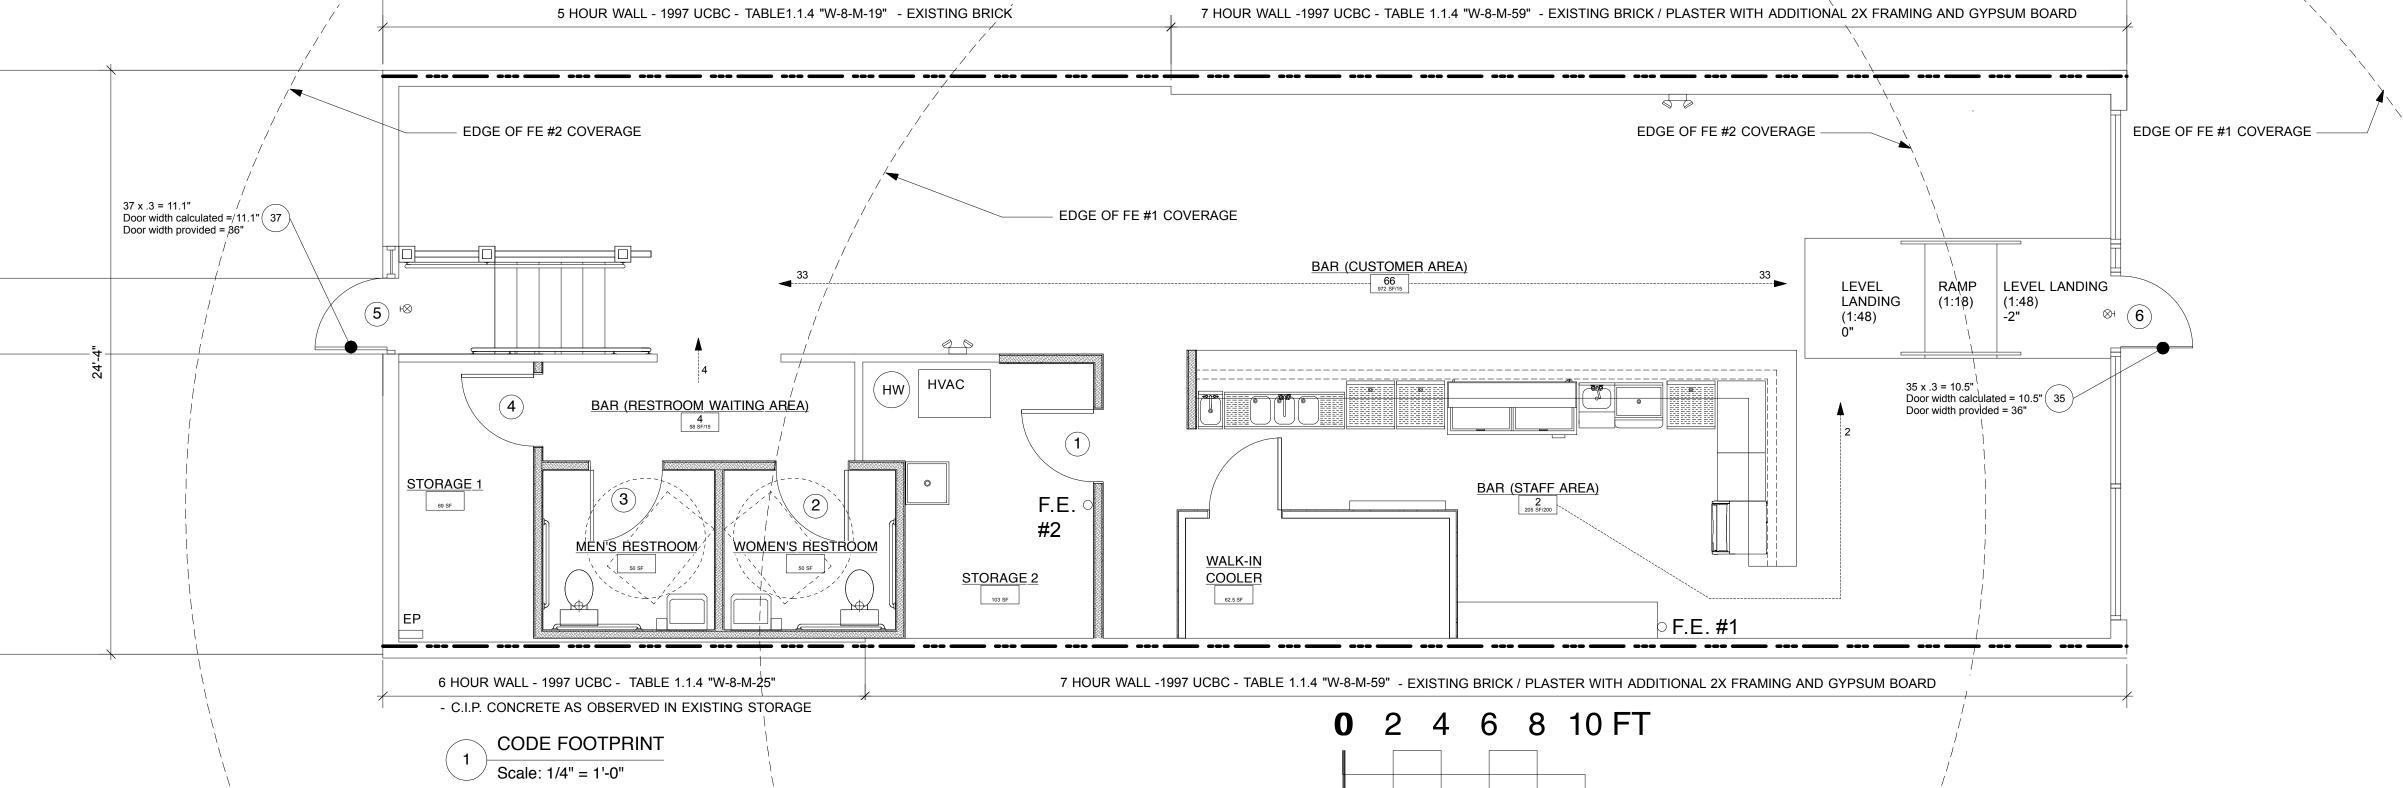








785-477-3379

SHEET NAME **Code Plan**

> Project #: 12-15 Filename: A1.mcd Issue Date: 1/25/13 SHEET NUMBER

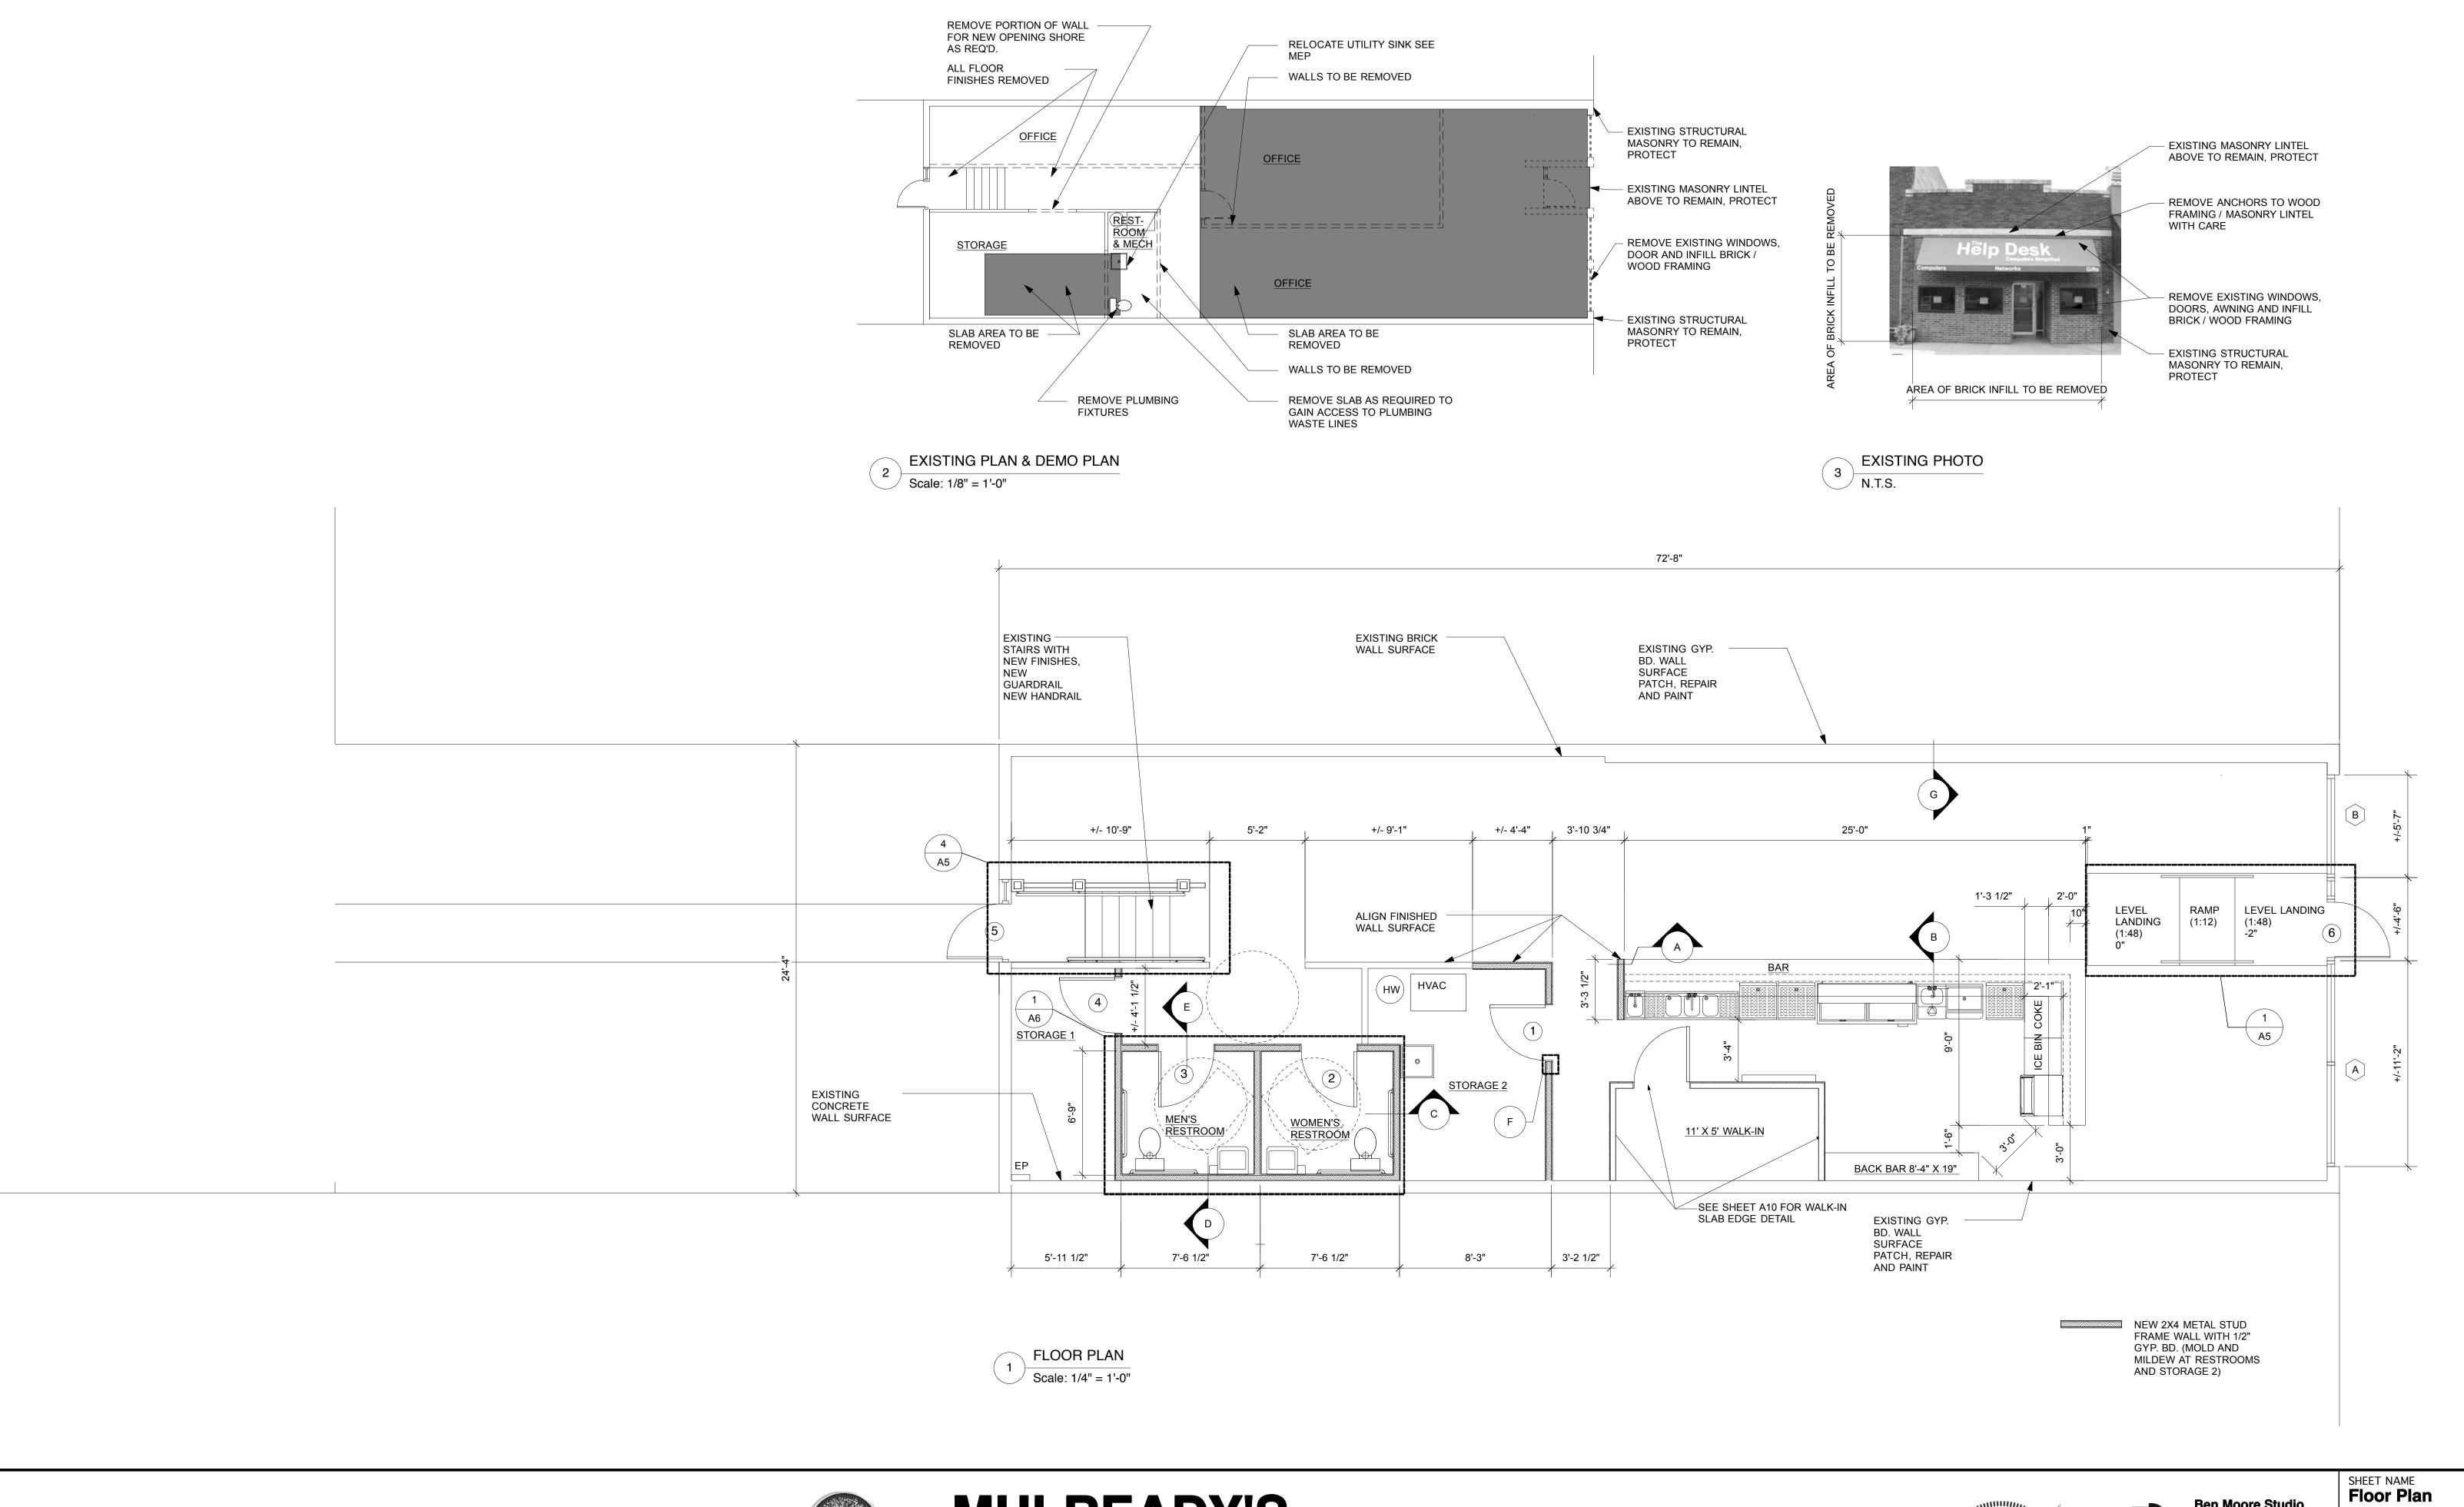









Council Grove, KS 66846


785-477-3379 ben@benmoorestudio.com


Issue: CD Project #: 12-15
Filename: A1.mcd
Issue Date: 1/25/13
SHEET NUMBER **A2**

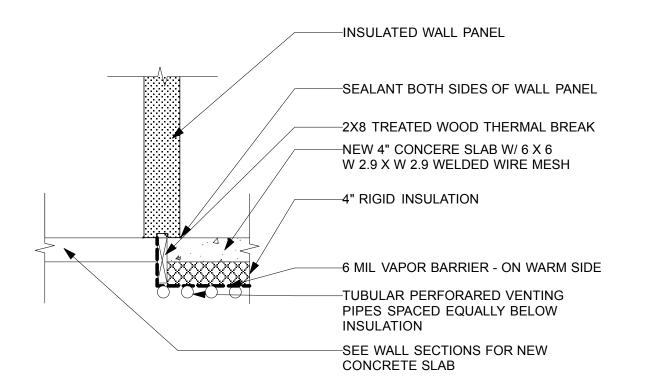



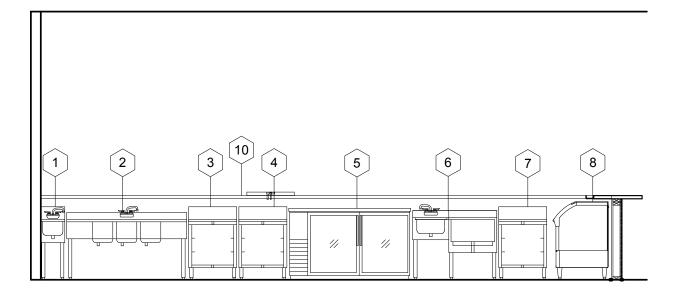

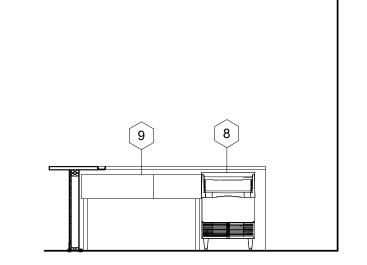

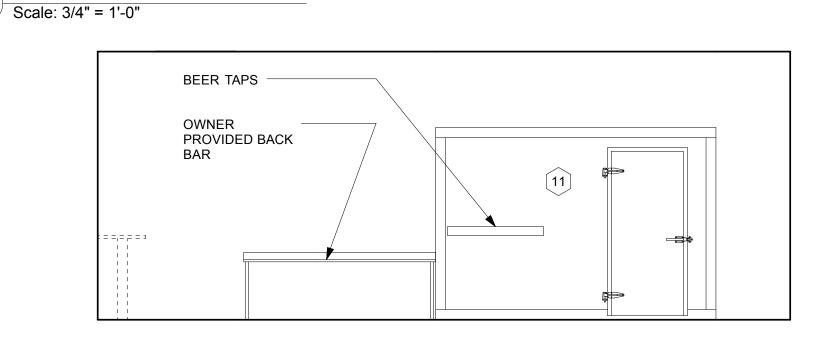

SCREED - WALK-IN MFR

-SWEEP GASKET - WALK-IN MFR

-BOTTOM PLATE - WALK-IN MFR

-STAINLESS STL. THRESHOLD

-RIGID INSULATION - 4" MIN.

-HEATER WIRE

CONCRETE SLAB

-NEW 4" CONCERE SLAB W/ 6 X 6 W 2.9 X W 2.9 WELDED WIRE MESH

-6 MIL VAPOR BARRIER - ON WARM SIDE

-2X8 TREATED WOOD THERMAL BREAK

-TUBULAR PERFORARED VENTING PIPES SPACED EQUALLY BELOW


INSULATION. COORDINATE WITH

KITCHEN EQUIPMENT SUPPLIER

-SEE WALL SECTIONS FOR NEW

BAR INTERIOR ELEVATIONS

WALK-IN COOLER DOOR DETAIL

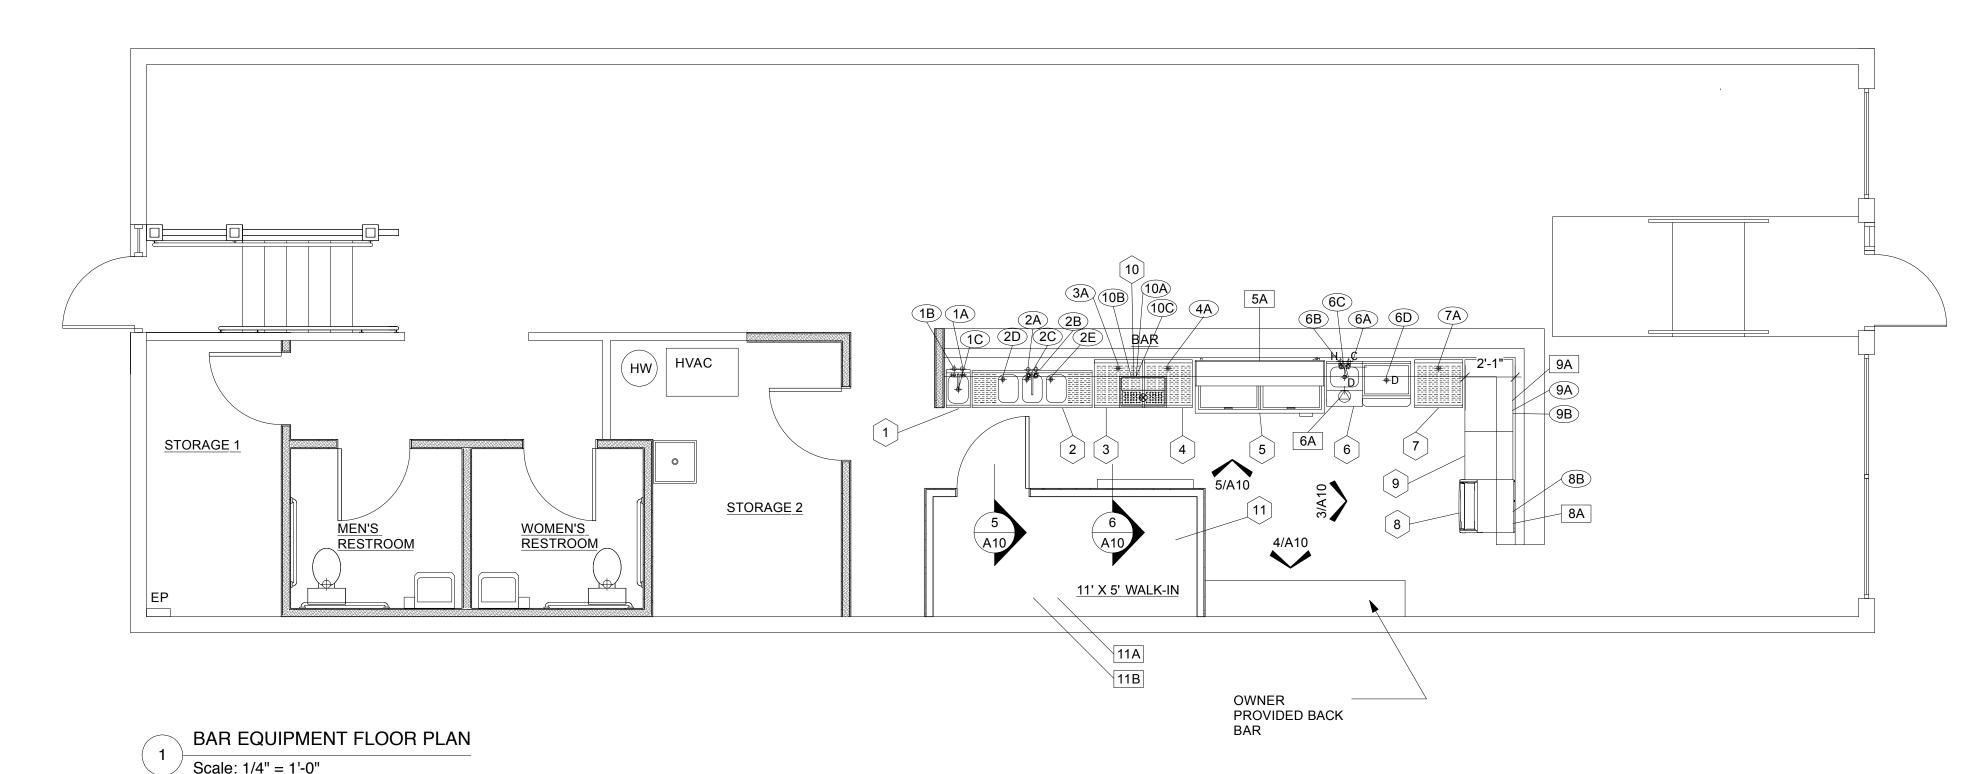

ELECTRICAL SCHEDULE

- 5A 115/60/1, 8.6 A., D.R. 24" A.F.F. 6A 115/60/1, 8.6 A., D.R. 24" A.F.F. 8A 115/60/1, 15 A. MAX, D.R. 24" A.F.F.
- 9A 115/60/1, 20 A., COORDINATE ELECT. LOCATION WITH MFR.
- 11A 115/60/1, 8.6 A., SEE MFR CUT SHEET FOR ELECT. LOCATION
- 11B 208/60/1, 8.6 A., UNIT ON ROOF COORDINATE LOCATION

PLUMBING SCHEDULE

- (1A) 1/2" C.W., S.O. 24" A.F.F. (PLUMB. CONTR. TO CONNECT TO FAUCET)
- (1B) 1/2" H.W., S.O. 24" A.F.F. (PLUMB. CONTR. TO CONNECT TO FAUCET)
- (1C) 1 1/2" WASTE., S.O. 20" A.F.F. (PLUMB. CONTR. TO CONNECT TO DRAIN)
- (2A) 1/2" C.W., S.O. 24" A.F.F. (PLUMB. CONTR. TO CONNECT TO FAUCET)
- (2B) 1/2" H.W., S.O. 24" A.F.F. (PLUMB. CONTR. TO CONNECT TO FAUCET)
- 2C 1 1/2" WASTE, S.O. 20" A.F.F. (PLUMB. CONTR. TO CONNECT TO DRAIN) (2D) 1 1/2" WASTE, S.O. 20" A.F.F. (PLUMB. CONTR. TO CONNECT TO DRAIN)
- (2E) 1 1/2" WASTE, S.O. 20" A.F.F. (PLUMB. CONTR. TO CONNECT TO DRAIN)
- (3A) 1" WASTE, S.O. 20" A.F.F. (PLUMB. CONTR. TO CONNECT TO DRAIN)
- (4A) 1" WASTE, S.O. 20" A.F.F. (PLUMB. CONTR. TO CONNECT TO DRAIN)
- (6A) 1/2" H.W., S.O. 20" A.F.F. (PLUMB. CONTR. TO CONNECT TO FAUCET) (6B) 1/2" C.W., S.O. 20" A.F.F. (PLUMB. CONTR. TO CONNECT TO FAUCET)
- (6C) 1 1/2" WASTE, S.O. 20" A.F.F. (PLUMB. CONTR. TO CONNECT TO DRAIN)
- (6D) 1 1/2" WASTE, S.O. 20" A.F.F. (PLUMB. CONTR. TO CONNECT TO DRAIN)
- (7A) 1" WASTE, S.O. 20" A.F.F. (PLUMB. CONTR. TO CONNEC TO DRAIN) (8B) 1" WASTE, S.O. 20" A.F.F. (PLUMB. CONTR. TO CONNECT TO DRAIN)
- (9A) 1/2" C.W., S.O. 20" A.F.F. (PLUMB. CONTR. TO CONNECT TO FAUCET)
- 9B) 1" WASTE, S.O. 20" A.F.F. (PLUMB. CONTR. TO CONNECT TO DRAIN)
- (10A) 1/2" C.W., S.O. 20" A.F.F. (PLUMB. CONTR. TO CONNECT TO FAUCET)
- (10B) 1" WASTE, S.O. 20" A.F.F. (PLUMB. CONTR. TO CONNECT TO DRAIN)
- (10C) DISPENSER: 12 BOTTON CONFIGURATION W/ 48" HOSE LENGTH

EQUIPMENT SCHEDULE

- HAND SINK MFR: KROWNE MODEL # KR18-1C
- BAR SINK MFR: KROWNE MODEL # KR18-53C
- GLASS STORAGE BIN MFR: KROWNE MODEL # KR18-GS81
- GLASS STORAGE BIN MFR: KROWNE MODEL # KR18-GS81
- UNDERBAR REFRIGERATOR MFR: TRUE MODEL # TD-65-24
- 6 BAR SINK MFR: KROWNE MODEL # TD-18-W42R
- GLASS STORAGE BIN MFR: KROWNE MODEL # KR18-GS81
- 8 ICE MACHINE MFR: SCOTSMAN MODEL # CU3030
- COKE EQUIPMENT MFR: COKE FOUNTAIN EQUIP-ICE TANNER-#2123
- 10 SPRITZER MFR: MICRO MATIC #DP-1605
- 11 WALK-IN COOLER MFR: THERMAL RITE 5'-0" X 11'-0"

GENERAL NOTES

- 1. ALL WORK SHALL BE DONE IN ACCORDANCE WITH APPLICABLE CODES
- 2. ALL DIMENSIONS ARE FROM THE FINISHED SURFACE OF WALLS, FLOORS OR CEILINGS
- 3. ALL DIMENSIONS INDICATED FOR ROUGH-INS SHALL BE TO THE CENTER OF THE ROUGH-IN.
- 4. UTILITY REQUIREMENTS SHOWN ON DRAWINGS ARE FOR THE FOOD
- 5. GENERAL CONTRACTOR SHALL PROVUDE IN-WALL BACKING FOR ALL MOUNTED FOOD SERVICE EQUIPMENT AS REQUIRED. COORDINATE WITH K.E.C. FOR TYPES, SIZES, AND LOCATIONS OF

ELECTRICAL NOTES

- ELECTRICAL ROUGH-INS AND FINAL CONNECTIONS TO EQUIPMENT SHALL BE BY ELECT. CONT. MATERIALS FOR EQUIPMENT CONNECTIONS SHALL BE FURNISHED AND INSTALLED BY ELECT. CONT. AS NOTED ON DRAWINGS
- ELECTRICAL DISCONNECTS ARE NOT FURNISHED WITH EQUIPMENT. THEY SHALL BE FURNISHED AND INSTALLED BY ELECT. CONTR. EXCEPT AS NOTED ON DRAWING
- 3. ALL CONDUIT SHALL BE CONCEALED IN WALLS, FLOORS OR CEILING EXCEPT ONLY WHERE ABSOLUTELY NECESSARY.
- ALL CONDUIT AND ELECTRICAL CORDS SHALL BE LOCATED UP OFF THE FLOOR TO FACILITATE FLOOR CLEANING AND SHALL BE SUPPORTED FROM ABOVE. FLOOR MOUNTED SUPPORTS SHALL NOT BE USED
- ELECT. CONTR. SHALL FURNISH AND INSTALL RECEPTACLES OF THE PROPER CONFIGURATION TO ACCOMMODATE THE PLUGS FURNISHED ON THE EQUIPMENT. COORDINATED WITH K. E. C.

PLUMBING NOTES

- 1. PLUMBING ROUGH-INS BY PLUMB. CONTR., INCLUDING FLOOR DRAINS, FLOOR SINKS, AND GREASE INTERCEPTORS
- 2. FINAL CONNECTIONS TO EQUIPMENT BY PLUMB. CONTR. SHALL CORRDINATE WITH K. E. C. ON CONNECTIONS TO EQUIPMENT
- MATERIAL FOR EQUIPMENT CONNECTIONS INCLUDING PIPING, FITTINGS STOPS, TRAPS, BACKFLOW PREVENTION DEVICEWS, AND PRESSURE REGULATORS FURNISHED AND INSTSLLED BY PLUMB. CONTR. EXCEPT AS NOTED ON DRAWING
- 4. ALL PIPING SHALL BE CONCEALED IN WALLS, FLOOR, OR CEILING EXCEPT ONLY WHERE ABSOLUTELY NECESSARY
- 5. ALL PIPING SHALL BE LOCATED UP OFF THE FLOOR TO FACILITATE FLOOL TO FACILITATE FLOOR CLEANING AND SHALL BE SUPPORTED FROM ABOVE. FLOOR MOIUNTED SUPPORTS SHALL NOT BE USED.
- 6. WATER FILTERS OR SOFTENERS NOT FURNISHED WITH EQUIPMENT EXCEPT AS NOTED ON DRAWINGS.
- 7. GAS PRESSURE REGULATORS SHALL BE FURNISHED WITH THE EQUIPMENET (BY K. E.C.) AND INSTALLED BY PLUMB. CONTR.
- 8. SINKS, FAUCETS, AND DRAIN FITTINGS FURNISHED BY K. E. C. AND INSTALLED BY PLUMB CONTR.

LEGEND

EQUIPMENT ITEM

PLUMBING REQUIREMENT

ELECTRICAL REQUIREMENT

WALK-IN NOTES

ABOVE FINISHED FLOOR. A. F. F. C.R.

COORDINATE RETURN COLD WATER C. W.

DUPLEX RECEPTALE D. R. **EQUIPMENT CONNECTION**

F. D. FLOOR DRAIN H. P. **HOUSE POWER**

H. W. HOT WATER JUNCTION BOX

K. E. C. KITCHEN EQUIPMENT CONTRACTOR

KILOWATT

K. W. P. W. PRE-WIRED

S. O. STUB OUT

S. S. STEM SUPPLY

S. R.

SINGLE RECEPTALE STUD UP S. U.









Project #: 12-15 Filename: A1.mcd 1501 H Avenue Issue Date: 1/25/13 Council Grove, KS 66846

SHEET NAME

Issue: CD

Kitchen Equip

SHEET NUMBER 785-477-3379 ben@benmoorestudio.com

ELECTRICAL:

- 1. ALL ELECTRICAL WORK SHALL COMPLY WITH THE 2005 NEC AND THE CITY OF EMPORIA REQUIREMENTS.
- 2. CONTRACTOR TO PROVIDE ALL REQUIRED EMERGENCY LIGHTING AS REQUIRED BY CURRENT BUILDING STANDARDS.
- 3. ALL CONDUCTORS SHALL BE 12 Ga. CU (THHN), AS A MINIMUM.
- 4. ELECTRICAL EQUIPMENT IS TO BE FURNISHED, INSTALLED, AND HOOKED UP BY E.C. (UNLESS OTHERWISE NOTED).
- 5. MATERIAL, DEVICES, EQUIPMENT, FIXTURES, ETC. SHALL BE NEW, UNUSED, AND HAVE THE U.L. LABEL. CEILING MOUNTED PENDENT FIXTURE SHALL BE SUPPLIED BY OWNER MAY BE USED FIXTURES.
- 6. ELECTRICAL CONTRACTOR (E.C.) SHALL VERIFY ALL EQUIPMENT REQUIREMENTS WITH THE OWNER, SUPPLIER, MECHANICAL CONTRACTOR, PLUMBING CONTRACTOR, ETC. AND SHALL PROVIDE AND INSTALL ALL ELECTRICAL REQUIREMENTS SHOWN AND NOT SHOWN BUT DESIGNATED AS HIS WORK.
- 7. PROVIDE ELECTRICAL SYSTEMS INDICATED ON DRAWINGS, SPECIFIED, OR REASONABLY IMPLIED.
 PROVIDE EVERY DEVICE AND ACCESSORY NECESSARY FOR PROPER OPERATION AND COMPLETION OF
 ELECTRICAL SYSTEMS. IN NO CASE WILL CLAIMS FOR 'EXTRA WORK' BE ALLOWED FOR WORK ABOUT
 WHICH ELECTRICAL CONTRACTOR COULD HAVE BEEN INFORMED BEFORE BID WERE RECEIVED.
- 8. ELECTRICAL CONTRACTOR TO LOCATE LIGHTING FIXTURES, RECEPTACLE, SWITCHES, ETC. APPROX. AS SHOWN. COORDINATE LOCATIONS WITH OTHER TRADES.
- 9. HEIGHT OF OUTLETS 18" A.F.F. (UNLESS OTHERWISE NOTED) HEIGHT OF SWITCHES 42" A.F.F (U.O.N.).
- 10. GROUND FAULT CIRCUIT INTERRUPTION PROTECTION MAY BE ACCOMPLISHED BY USING PROTECTED RECEPTACLES OR PROTECTED CIRCUT BREAKERS. MULTIPLE RECEPTACLES MAY BE PROTECTED FROM ONE PROTECTED RECEPTACLE PER MANUFACTURER'S INSTRUCTIONS.
- 11. PROVIDE PHOTO CELL CONTROL FOR ALL EXTERIOR LIGHTS.
- 12. EXISTING 200A 115/208V 3φ ELECTRICAL SERVICE TO REMAIN.
- 13. UNUSED ELECTRICAL DEVICES SHALL BE REMOVED AND DISCONNECTED BACK TO LAST JUNCTION BOX TO REMAIN.
- 14. SEE SHEET A10 FOR ADDITIONAL ELECTRICAL NOTES AND EQUIPMENT SCHEDULE.

PANEL SCHEDULE 200A-115/208V, 3φ, 3 WIRE W/ 200A MAIN

V V / 200/ \ IVI/ \II \				
NO.	DESCRIPTION	C/B SIZE		
1	CONDENSING UNIT *	40A 3P		
2	CONDENSING UNIT *			
3	CONDENSING UNIT *			
4	LIGHTS #1	20A 1P		
5	LIGHTS #2	20A 1P		
6	LIGHTS #3	20A 1P		
7	LIGHTS #4	20A 1P		
8	RECEPTS #1	20A 1P		
9	RECEPTS #2	20A 1P		
10	RECEPTS #3	20A 1P		
11	RESTROOM #1	20A 1P		
12	OPEN	20A 1P		
13	FURNACE *	20A 1P		
14	STORAGE	20A 1P		
15	SIGN CIRCUIT	20A 1P		
16	OPEN	20A 1P		
17	OPEN	20A 1P		
18	OPEN	20A 1P		
19	FOUNTAIN EQUIP-ICE (9)	20A 1P		
20	OPEN	20A 1P		
21	OPEN	20A 1P		
22	OPEN	20A 1P		
23	OPEN	20A 1P		
24	OPEN	20A 1P		
25	OPEN	20A 1P		
26	ICE MACHINE (8)	15A 1P		
27	UNDERBAR REFRIGERATOR (5)	15A 1P		
28	WALK-IN FREEZER 11	15A 1P		
29	WALK-IN FREEZER 11	15A 2P		
30	WALK-IN FREEZER (11)			

NOTE:
* INDICATES EXISTING CIRCUIT. ACTUAL SERVICE
PANEL CIRCUITS SHALL BE DETERMINED BY OTHERS
TO MINIMIZE REWIRING OF THE SERVICE PANEL.

LEGEND

-− 100W LIGHT FIXTURE

DUPLEX ELECTRICAL OUTLET

GFI GROUND FAULT INTERRUPTER

EXHAUST FAN

4 BULB FLOURESCENT FIXTURE

COMBINATION EXIT/EMERGENCY
EXIT LIGHT WITH BATTERY BACKUP W/

REMOTE EXTERIOR LIGHT

EMERGENCY LIGHT WITH
BATTERY BACKUP

RECEPTS #2 CIRCUIT HOMERUN

5 CIRCUIT CALL-OUT

100W EXTERIOR LIGHT FIXTURE

\$ SINGLE POLE SWITCH

\$₃ 3-WAY SWITCH

 $\$_{D}$ DIMMER SWITCH

(J) JUNCTION BOX

D DISCONNECT

THEDMOST

① THERMOSTAT

CENTRAL!

WADE OF THE STATE OF THE STATE

ELECTRICAL PLAN
17 COMMERICAL ST
EMPORIA. KS

Date: 02-04-13

Designed: DWO


Drawn: KHG

Checked: DWO

Approved:
Proj. No.

Sheet No:

F100

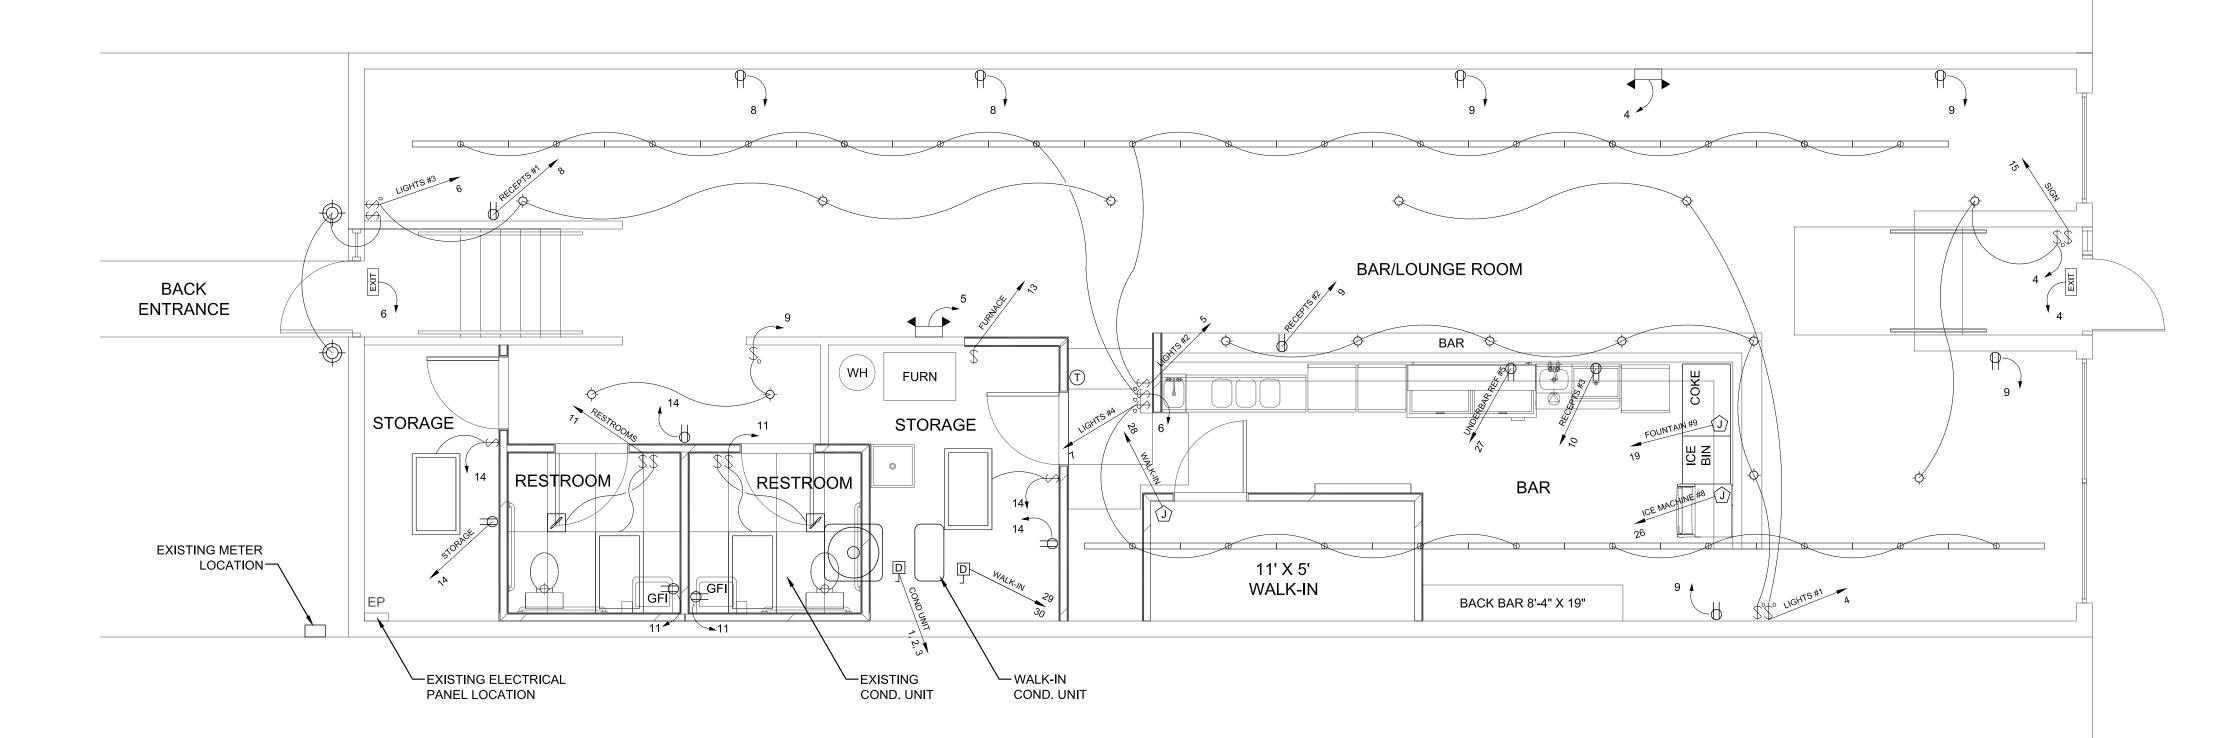

MECHANICAL NOTES:

- 1. ALL HVAC WORK SHALL COMPLY WITH THE 2003 UMC AND THE CITY OF EMPORIA REQUIREMENTS. ALL EQUIPMENT SHALL BE INSTALLED IN ACCORDANCE WITH MANUFACTURER'S RECOMMENDATIONS AND THE LISTING AGENTS REQUIREMENTS.
- 2. PROVIDE STRUCTURAL SUPPORT TO BUILDING STRUCTURE SUFFICIENT TO SAFELY SUPPORT ALL PIPING AND EQUIPMENT.
- 3. SEE PLUMBING FIXTURE SCHEDULE AND HVAC EQUIPMENT SCHEDULE FOR UNIT CAPACITY/REQUIREMENTS.
- 4. NEW SUPPLY AIR DUCTING TO BE METAL DUCT WITH $\frac{1}{2}$ " x 2 LB. INSULATION (MIN.) OR INSULATED ROUND METAL DUCT. NOTE: ALL DUCT SIZES ARE INSIDE DIMENSIONS. RETURN AIR DUCT TO BE INSULATED METAL DUCT. INSULATED, FACTORY-MADE AIR DUCTS ARE ACCEPTABLE.
- 5. PROVIDE RETURN AIR GRILLS AT ALL RETURN AIR LOCATIONS. PROVIDE DIFFUSERS/REGISTERS AT SUPPLY AIR OUTLETS AND ADJUST TO PROVIDE REQUIRED CFM.
- 6. PROVIDE COMBUSTION AIR OPENINGS (VERTICAL) IN MECHANICAL ROOM. ONE OPENING WITH SCREEN AND LOUVER WITHIN 12" OF CEILING. SECOND OPENING WITH SCREEN AND LOUVER TO WITHIN 12" OF FLOOR. EACH DUCT TO BE SIZED AT 1 SQ. IN. NET FREE AREA PER 4000 BTUH.
- 7. HVAC CONTRACTOR TO LOCATE SUPPLY AND RETURN DIFFUSERS/REGISTERS APPROXIMATELY AS SHOWN ON PLANS. COORDINATE LOCATIONS WITH OTHER TRADES. SEE ELECTRICAL PLANS FOR LIGHTING/CEILING LAYOUT.
- 8. PROVIDE THERMOSTAT FOR HEATING UNIT, LOCATED PER OWNER.
- 9. EXHAUST FAN EXHAUST DUCTS SHALL BE TERMINATED PER DETAIL I/A4.
- 10. PROVIDE FRESH AIR VENTILATION PER SECTION 1203.3 OF THE 2006 IBC.
- 11. PROVIDE 1 HOUR RATED FIRE DAMPERS AT ALL DUCT PENETRATIONS THROUGH WALLS AND CEILING OF ALL—FIRE PROTECTED AREAS.
- 12. PROVIDE IN-DUCT SMOKE DETECTORS PER UMC SECTION 608.
- 13. EXISTING BUILDING HVAC SYSTEM CONSISTS OF FURNACE ON 1ST FLOOR AND CONDENSING UNIT ON THE ROOF. EXISTING EQUIPMENT AND DUCTS SHALL REMAIN AND BE REPAIRED OR REPLACE AS NECESSARY TO HAVE AN OPERATIONAL SYSTEM.
- 14. NEW REST ROOM EXHAUST FANS SHALL BE BROAN MODEL SP100, 110 CFM, 120V, OR EQUIVALENT.

-REMOVE **EXISTING** DUCT /-- 24" X 24 " RETURN BAR/LOUNGE ROOM AIR GRILLE DUCTED **EXISTING** TO FURNACE SUPPLY PLENUM — BACK FURNACE PVC
EXHAUST AND **ENTRANCE** VENT PIPES BAR NEW 10" X 8" METAL DUCT STORAGE EXISTING GAS
LINE TO BE
RELOCATED — `—EXISTING TYPE "B" FLUE -COMBUSTION \RESTROOM | RESTROOM AIR PIPES 11' X 5' WALK-IN STORAGE BACK BAR 8'-4" X 19" -NEW EXHAUST FAN -NEW EXHAUST FAN IN SUSPENDED CEILING IN SUSPENDED CEILING TERMINATE THRU ROOF TERMINATE THRU ROOF

Drawing Path: G:□ckec on 'server (10.1.1.160)' (Z)□Projects□2012.039 Ben Moore Architect_Mulready Bar□dwg□2012.039 Mulready Plotted at: Feb 06, 2013 - 8:33am

MECHANICAL PLAN

SCALE: 1/4" = 1'-0"

CENTRAL KANSAS ENGINEERING CONSULTANTS, L. L. C. C. CIVIL ENGINEERING - PLANNING - CONSTRUCTION MANAGEMENT 17 West 5th Ave., Emporia, KS 66801

CK

MECHANICAL PLA 717 COMMERCIAL EMPORIA. KS

Date: 02-04-16
Designed: DWO
Drawn: KHG
Checked: DWO

Approved:
Proj. No.

Sheet No:

M100

5 4 4 3 3 1 No.

Sheet No:

1. ALL PLUMBING WORK SHALL COMPLY WITH THE 2006 UPC AND THE CITY OF EMPORIA REQUIREMENTS. ALL EQUIPMENT SHALL BE INSTALLED IN ACCORDANCE W/

GAS LINE NOTES:

SUPPORT ALL GAS LINES AND EQUIPMENT.

AND SHALL BE PRESSURE TREATED. U.N.O.

1. ALL PLUMBING WORK SHALL COMPLY WITH THE 2006 UPC AND THE CITY OF EMPORIA

MANUFACTURER'S RECOMMENDATIONS AND THE LISTING AGENTS REQUIREMENTS.

REQUIREMENTS. ALL EQUIPMENT SHALL BE INSTALLED IN ACCORDANCE WITH

2. PROVIDE STRUCTURAL SUPPORT TO BUILDING STRUCTURE SUFFICIENT TO SAFELY

3. ALL GAS SUPPLY LINES TO EQUIPMENT FROM MAIN SUPPLY LINE SHALL BE 3/4"

6. ALL GAS APPLIANCES SHALL HAVE SHUT-OFF VALVES, UNIONS AND DIRT LEGS.

7. ALL GAS PIPE TO BE BLACK IRON WITH THREAD SEALANT AT ALL THREADED JOINTS

UNLESS MANUFACTURER'S INSTRUCTION SPECIFICATIONS DIFFER.

4. PROVIDE FLUE PIPES THROUGH ROOF FOR GAS APPLIANCES PER PLAN.

5. SEE GAS PIPING PLANS FOR GAS SUPPLY TO GAS EQUIPMENT SHOWN.

- 2. CONTRACTOR TO RELOCATE PLUMBING, AS REQUIRED, TO COMPLETE CONSTRUCTION.
- 3. VENT PIPES SHALL EXTEND THROUGH FLASHING AND TERMINATE NOT LESS THAN 6 INCHES ABOVE THE ROOF. VENT TERMINATION 3 FEET ABOVE OR WITHIN 10 FEET HORIZONTALLY OF ANY OPERABLE WINDOW, DOOR, OR AIR INTAKE ARE NOT PERMITTED.
- 4. DOMESTIC WATER LINES SHALL BE TYPE "M" COPPER ABOVE GRADE AND TYPE "K"
- 5. CONSOLIDATE ALL VENT LINES TO MINIMIZE ROOF PENETRATIONS.
- 7. INSULATE ALL WATER LINES, DRAIN LINES, AND TRAPS WHICH ARE EXPOSED TO FREEZING TEMPERATURE.
- 8. BATHROOM LAVATORIES SHALL HAVE $1\frac{1}{2}$ " DRAIN AND $1\frac{1}{2}$ " VENT LINES.
- 9. SINKS, MOP SINK AND FLOOR DRAINS SHALL HAVE 2" DRAINS AND 1½" VENT LINES.
- FIXTURES REMAIN.
- 12. HORIZONTAL TO HORIZONTAL, HORIZONTAL TO VERTICAL, AND VERTICAL TO HORIZONTAL PIPING FITTINGS SHALL BE LONG TURN FITTINGS.
- BE RESPONSIBLE FOR LOCATING AND SALVAGING EXISTING PIPING, AS NECESSARY, TO COMPLETE CONSTRUCTION.
- 14. UNLESS OTHERWISE NOTED, WATER SUPPLY LINES SHALL BE $\frac{3}{4}$ " CU.
- 15. EXISTING WATER LINES AND DWV LINES TO BE REUSED TO MAXIMUM EXTENT POSSIBLE. (REPLACE CORRODED/LEAKING LINES AS NECESSARY). CAP OFF AND REMOVE EXISTING LINES NOT TO BE RE-USED.

PLUMBING:

-1" COLD

³⁄₄" METER

WATER

SERVICE

1" BUILDING SUPPLY

& COLD

& COLD

- MANUFACTURER'S RECOMMENDATIONS AND THE LISTING AGENTS REQUIREMENTS.

- COPPER BELOW GRADE. SANITARY SEWER LINES SHALL BE PVC, SCHEDULE 40.
- 6. AGGEGATE CROSS-SECTIONAL AREA OF ALL VENTS TO BE NOT LESS THAN THAT OF THE LARGEST REQUIRED COMMON BUILDING SEWER.
- 10. WATER CLOSETS SHALL HAVE 3" DRAINS AND 2" VENTS.
- 11. HOT AND COLD WATER SUPPLY LINES ARE TO BE $\frac{3}{4}$ " MIN. UNTIL NO MORE THAN 2
- 13. ALL PLUMBING IS SHOWN IN APPROXIMATE LOCATIONS, ONLY. CONTRACTOR SHALL
- 16. SEE SHEET A10 FOR ADDITIONAL PLUMBING NOTES AND EQUIPMENT SCHEDULE.

FIXTURE SCHEDULE

<u>1</u>" HOT

³/₄" HOT —∕ $\frac{3}{4}$ " COLD -

& COLD

HEATER -

½" COLD _

ੀ" COLD _


LAV. KOHLER WHITE 19" BROOKLINE VITREOUS CHINA 1 HOLE LAV. (ADA COMPLIANT WHEN INSTALLED IN 21" MINIMUM DEPTH COUNTER TOP). WITH DELTA SINGLE HANDLE LAVATORY FAUCET D540WFMPU (CHROME PLATED LEVER HANDLE). OR ACCEPTABLE EQUIVALENT

WATER CLOSET KOHLER WHITE HIGHLINE COMFORT HEIGHT EB BOWL WITH 2 TRAPS. OR ADA EQUIVALENT (2) WHITEHAUS COLLECTION DROP-IN DOUBLE BOWL BAR

SINKS WITH 7" DEPTH MINIMUM, WITH VOLA KV3 TWO HAND FAUCET W/ DOUBLE SWIVEL SPOUT OR ACCEPTABLE EQUIVALENT KITCHEN SINK STERLING SPRO2522- 3 HOLE STAINLESS STEEL SINK 6" DEPTH MINIMUM. WITH DELTA SINGLE HANDLE KITCHEN FAUCET D150WF 3 HOLE INSTALLATION.

OR ACCEPTABLE EQUIVALENT SERBER SIPHON JET/TOP SPUD WALL HUNG URINAL (MODEL #27-770) WITH SLOAN ROYAL (MODEL #186) EXPOSED URINAL FLUSHOMETER OR ACCEPTABLE EQUIVALENT.

GRIFFIN FLOOR MOP SINK (MODEL #9-OP-20) WITH OVERALL DIM. 21"x25" (2" DRAIN) WITH MOP SINK FAUCET (MODEL #804002-B) OR ACCEPTABLE EQUIVALENT

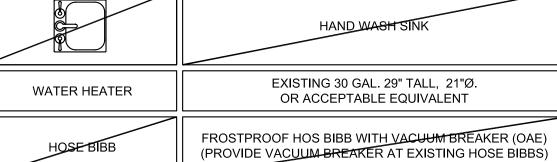


FLOOR DRAINS

CLEANOUT

2" PLASTIC ODDITIES PVC FLOOR DRAIN WITH CHROME STRAINER (OAE)

2" PLASTIC ODDITIES PVC FLOOR CLEANOUT WITH CHROME COVER (OAE)

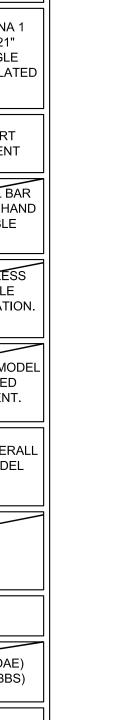


1" COLD —

WATER SUPPLY RISER DIAGRAM

EXISTING GAS METER (APPROX. LOCATION) — BAR/LOUNGE ROOM **EXISTING BACK** WATER HEATER — **ENTRANCE** -RELOCATE /—¹″ HOT & COLD EXISTING
FURNACE EXISTING & COLD & COLD — GAS LINE BAR ³/₄" HOT − TRUE-TD-65-24 ³/₄" COLD — STORAGE RESTROOM —1 " COLD $\frac{3}{4}$ " METER ½" COĻ∕D− 1" BUILDING BAR SUPPLY — RESTROOM EXISTING & COLD GAS SUPPLY — ½" COLD STORAGE 11' X 5' WALK-IN BACK BAR 8'-4" X 19"


> WATER PLUMBING PLAN SCALE: 1/8" = 1'-0"

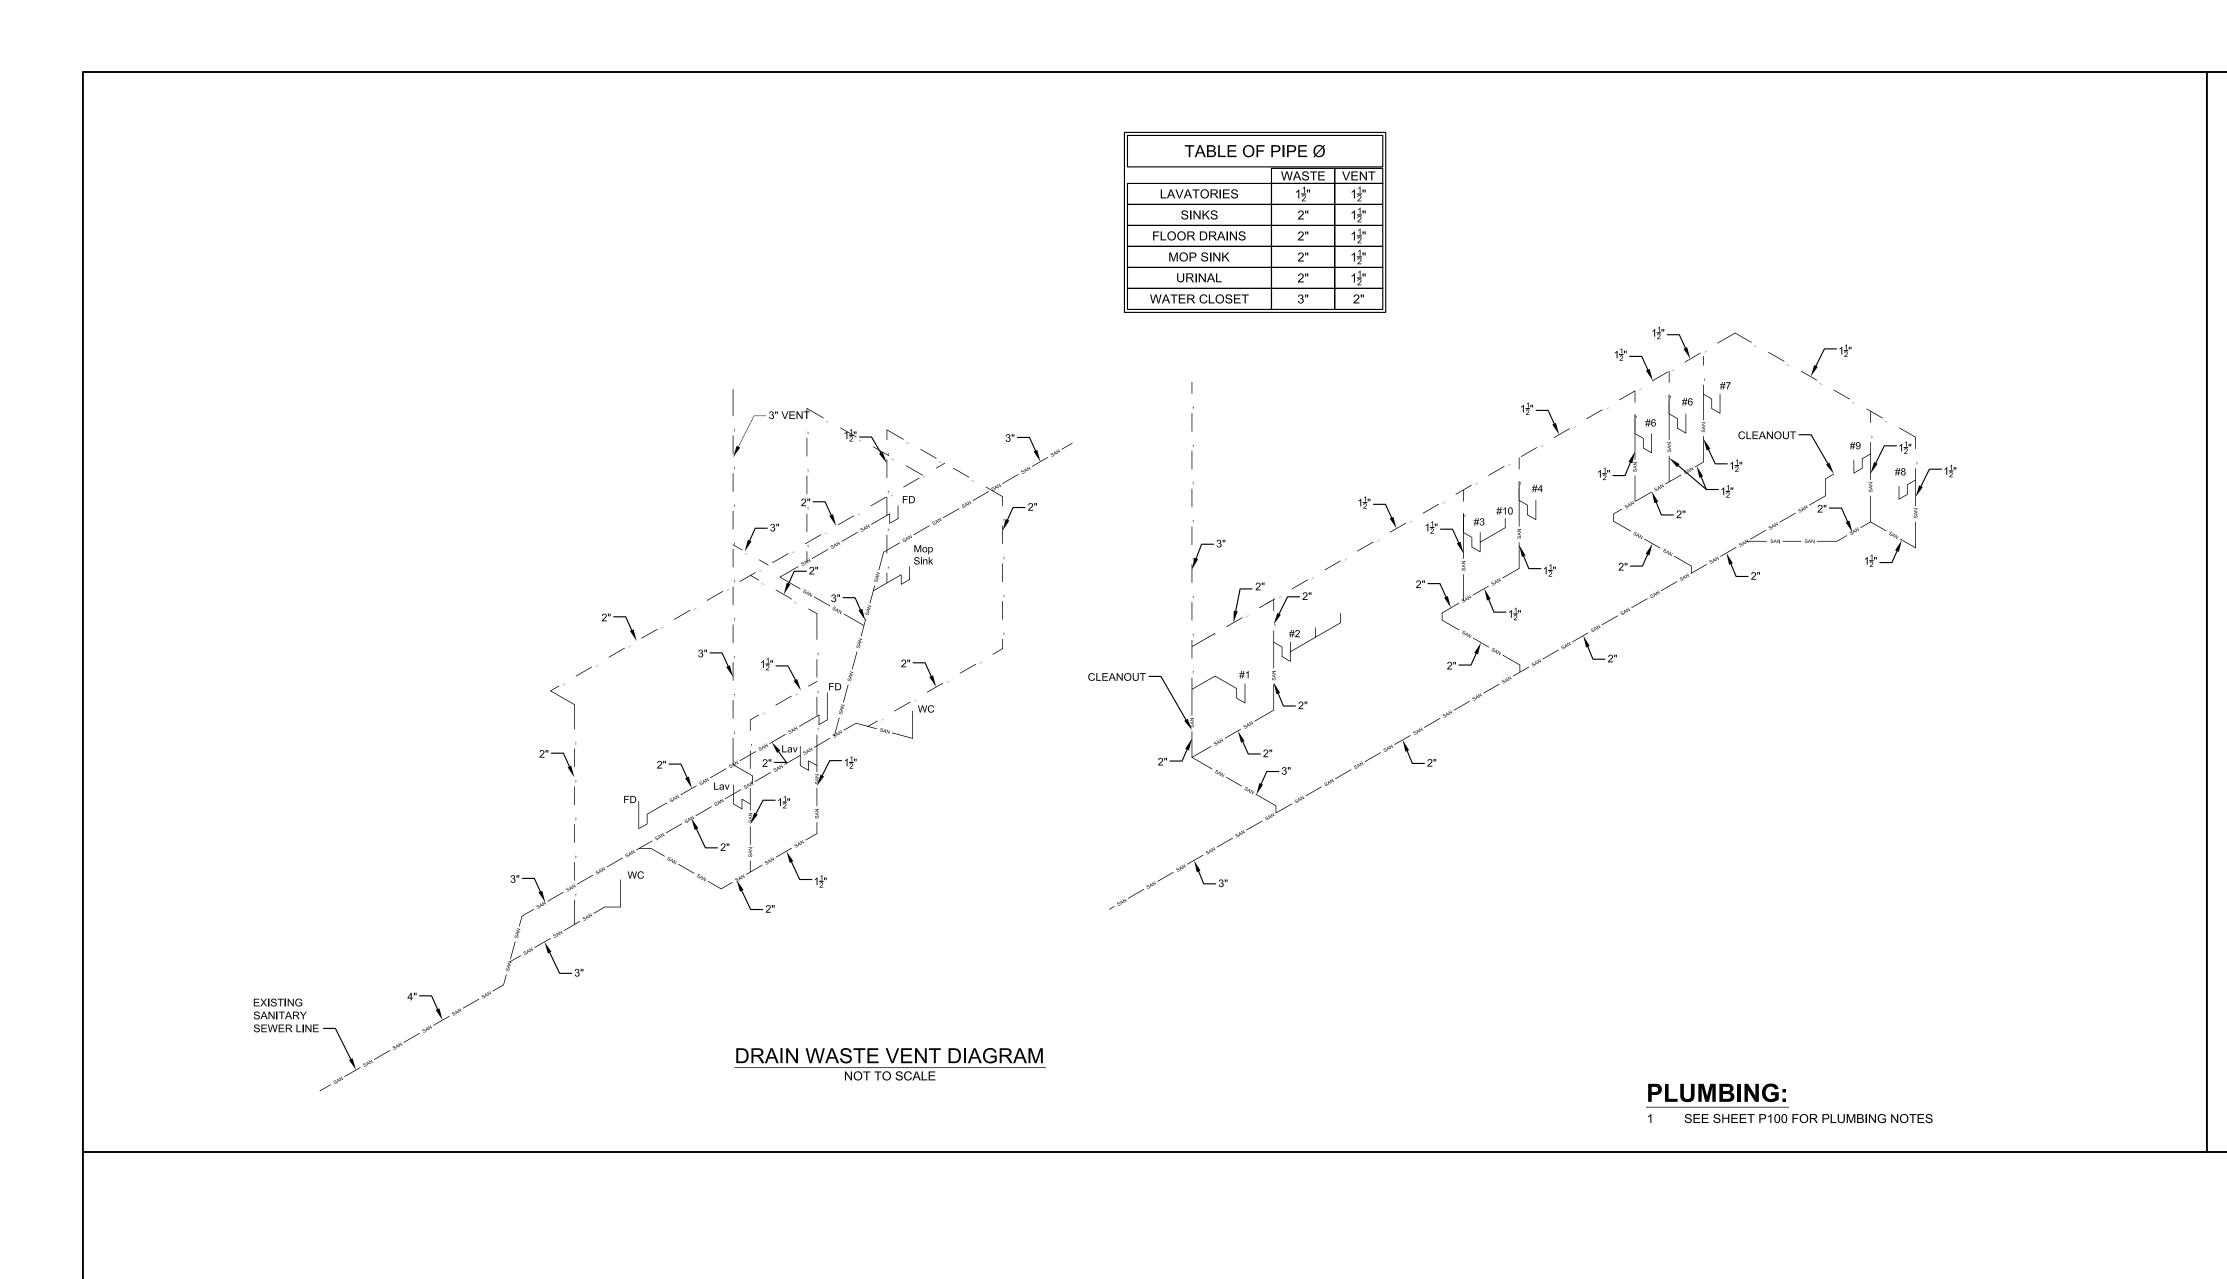

BAR/LOUNGE ROOM 3" VENT THRU THE ROOF BACK CLEANOUT — ENTRANCE 2" VENT 2" WASTE 1¹/₂" VENT _ CLEANOUT (ACCESS IN WALL) 3" VENT THRU THE ROOF — DRAIN STORAGE EXISTING SANITARY SEWER— RESTROOM/ 2" WASTE — 2" WASTE FLOOR — DRAIN STORAGE 1½" WASTE 1½" VENT ──2" WASTE BAR 1½" VENT 11' X 5' WALK-IN 1½" WASTE 1½" VENT — san — san — san — san — EP BACK BAR 8'-4" X 19" 2" WASTE 1½" VENT __/ 3" WASTE 2" VENT — 1½" WASTE 1½" VENT 2" VENT

BUILDING DRAINAGE PLAN
SCALE: 1/8" = 1'-0"



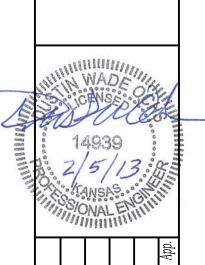

No.

BUILDING DRAIN PLAN 717 COMMERICAL EMPORIA, KS

Date: 02-04-13 Designed: DWO Drawn: KHG Checked: DWO

Proj. No. 12.039

Sheet No: